HIGHLAND - WALLOON - STAGE 1C

197 TAYLORS ROAD CIVIL WORKS - OPERATIONAL WORKS PACKAGE



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LOCALITY PLAN SCALE 1:2000 (A1)

DRAWING INDEX

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PROJECT SUMMARY INFORMATION

NUMBER OF PROPOSED LOTS	12					
AREA OF PROPOSED SITE	0.85ha					
REAL PROPERTY DESCRIPTION	LOT 555 ON M33493					
PERMANENT SURVEY MARK	PM67024, AHD 67.357					
	GDA2020 LAT/LONG: -27.592705853, 152.644298479					
	GDA1994 LAT/LONG: -27.592718445, 152.644292419					
ALL DRAWING COORDINATES TO GDA1994						


Pursuant to the Planning Act 2016, this plan forms part of **Council's approval for**


Approval No: 11153/2022/OW

Date: 12/03/2024

REV	DATE	AMENDMENT \ REVISION DESCRIPTION	DRAFT	DESIGN	WVR No.	STATUS	
01	26.09.22	ISSUED FOR APPROVAL	KG	AY	0015		
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						APPROVED ^	RPEQ: 10082
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						<u> </u>	
						TPAMELA ARCONADO	DATE 26.09.2022



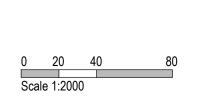

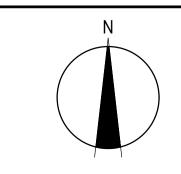

CLIENT	PROJECT
LENNIUM	
———— G R O U P ———	DATUM
	AHD

HIGHLAND - WALLOON STAGE 1C 197 TAYLORS ROAD, WALLOON IPSWICH CITY COUNCIL

GENERAL COVER SHEET

PROJECT\DRAWING No 30032066-01C-100 AS SHOWN

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GENERAL NOTES:

- 1. CONTRACT DOCUMENTATION
- ALL DRAWINGS UNDER THIS CONTRACT ARE TO BE READ IN CONJUNCTION WITH THE PROJECT SPECIFICATION.
- 2. SURVEY INFORMATION
 - CONTROL SURVEY INFORMATION WILL BE ESTABLISHED ON SITE BY THE PRINCIPAL'S SURVEYOR. SETOUT INFORMATION SHALL NOT BE OBTAINED BY SCALING FROM THESE DRAWINGS.
- 3. DATUM
- ALL LEVELS SHOWN ON DRAWINGS ARE A.H.D. (DERIVED).
- 4. EXISTING SURVEY CONTROL STATIONS
- THE CONTRACTOR IS TO ENSURE THAT SURVEY CONTROL STATIONS ARE NOT DAMAGED OR DISTURBED IN ANY WAY BY CONSTRUCTION ACTIVITIES.
- EXISTING SERVICES
- EXISTING SERVICES LOCATIONS WHERE SHOWN ON THE DRAWINGS ARE INDICATIVE ONLY. THE CONTRACTOR SHALL CONTACT THE RELEVANT AUTHORITIES TO ASCERTAIN THE EXACT LOCATION OF ALL EXISTING SERVICES PRIOR TO COMMENCEMENT OF WORK AND SHALL TAKE ALL NECESSARY PRECAUTIONS TO AVOID DAMAGE TO EXISTING SERVICES.
- 6. SITE ACCESS
- THE CONTRACTOR SHALL GAIN ACCESS TO THE SITE AT LOCATIONS APPROVED BY THE SUPERINTENDENT. FREEDOM OF ACCESS TO OTHER WORK AREAS ON THE SITE SHALL BE MAINTAINED AT ALL TIMES.
- 7. PROVISION FOR TRAFFIC
- PROVISION FOR TRAFFIC ON LOCAL ROADS IS TO BE IN ACCORDANCE WITH THE MANUAL OF UNIFORM TRAFFIC CONTROL DEVICES AND LOCAL AUTHORITY REQUIREMENTS.
- 8. WORK BOUNDARIES
- THE CONTRACTOR IS TO RESTRICT ACTIVITIES TO THOSE AREAS DESIGNATED AS WORK AREAS UNDER THIS CONTRACT. AT NO TIME SHALL THE CONTRACTOR ENTER ADJOINING PROPERTIES OR CONTRACT WORK AREAS ON THE SITE WITHOUT WRITTEN AUTHORISATION FROM THE SUPERINTENDENT.
- 9. SITE CLEARING
- CLEARING AND GRUBBING SHALL BE CARRIED OUT TO ALL WORK AREAS AS SPECIFIED AND SHALL INCLUDE THE REMOVAL OF ALL EXISTING TREES (UNLESS NOMINATED TO BE PRESERVED), EXISTING VEGETATION, TIMBER, FENCES AND ANY OTHER DEBRIS.
- 10. TOPSOIL STRIPPING
 - ALL TOPSOIL STRIPPED FROM WORK AREAS SHALL BE STOCKPILED FOR LATER RE-SPREADING TO ALL FOOTPATHS, BATTERS AND FILL AREAS.
- 11. COMPACTION STANDARDS
- ALL FILL MATERIAL PLACED UNDER THIS CONTRACT SHALL BE COMPACTED IN ACCORDANCE WITH THE IPSWICH CITY COUNCIL STANDARD SPECIFICATION.
- 12. TOPSOIL REPLACEMENT AND GRASSING
- FOLLOWING COMPLETION OF ROADWORKS CONSTRUCTION AND BULK EARTHWORKS OPERATIONS THE FULL EXTENT OF FOOTPATHS, BATTERS AND FILL AREAS IS TO BE RE-TOPSOILED TO A MINIMUM DEPTH OF 75mm AND GRASSED AS FURTHER DETAILED IN THE SPECIFICATION.
- 13. TESTING
- ALL TESTING SHALL BE CARRIED OUT BY AN APPROVED N.A.T.A. TESTING AUTHORITY IN ACCORDANCE WITH THE PROJECT SPECIFICATION.
- 14. AS CONSTRUCTED" SURVEY "
- AS CONSTRUCTED" SURVEY SHALL BE CARRIED OUT BY THE PRINCIPAL'S SURVEYOR AS WORK PROCEEDS.
- 15. MAINTENANCE OF SITE CONDITION
- AT THE COMPLETION OF WORKS THE SITE IS TO BE LEFT IN A CLEAN AND TIDY CONDITION TO THE SATISFACTION OF THE SUPERINTENDENT AND IPSWICH CITY COUNCIL.

EARTHWORKS NOTES

1. EARTHWORKS FOR CURRENT STAGE WORKS COMPLETED AS PART OF STAGE 1A OPERATIONAL WORKS. REFER 30032066-01A-120 AND 140 SERIES FOR EARTHWORKS INFORMATION.

EROSION AND SEDIMENT CONTROLS NOTES

EROSION AND SEDIMENT CONTROLS FOR CURRENT STAGE WORKS COMPLETED AS PART OF STAGE 1A OPERATIONAL WORKS. REFER 30032066-01A-160 & 180 SERIES FOR EROSION AND SEDIMENT CONTROLS INFORMATION.

RETAINING WALL NOTES

- 1. 30032066-01A-120 TO 140 SERIES IS TO BE READ IN CONJUNCTION WITH CURRENT STAGE (1C) PLANS TO DETERMINE LOCATIONS OF 1 IN 2 INTERIM BATTERS.
- 2. ALL PROPOSED RETAINING WALL LOCATIONS IN CURRENT STAGE (1C) PLANS ARE TO BE CONSTRUCTED WHERE PREVIOUS STAGE 1A BATTERS ARE LOCATED.

Pursuant to the Planning Act 2016, this plan forms part of **Council's approval for**

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PAMELA ARCONADO

DATE 26.09.2022





HIGHLAND - WALLOON STAGE 1C 197 TAYLORS ROAD, WALLOON


GENERAL NOTES

IPSWICH CITY COUNCIL AS SHOWN A1

PROJECT\DRAWING No 30032066-01C-110

REVISION

01

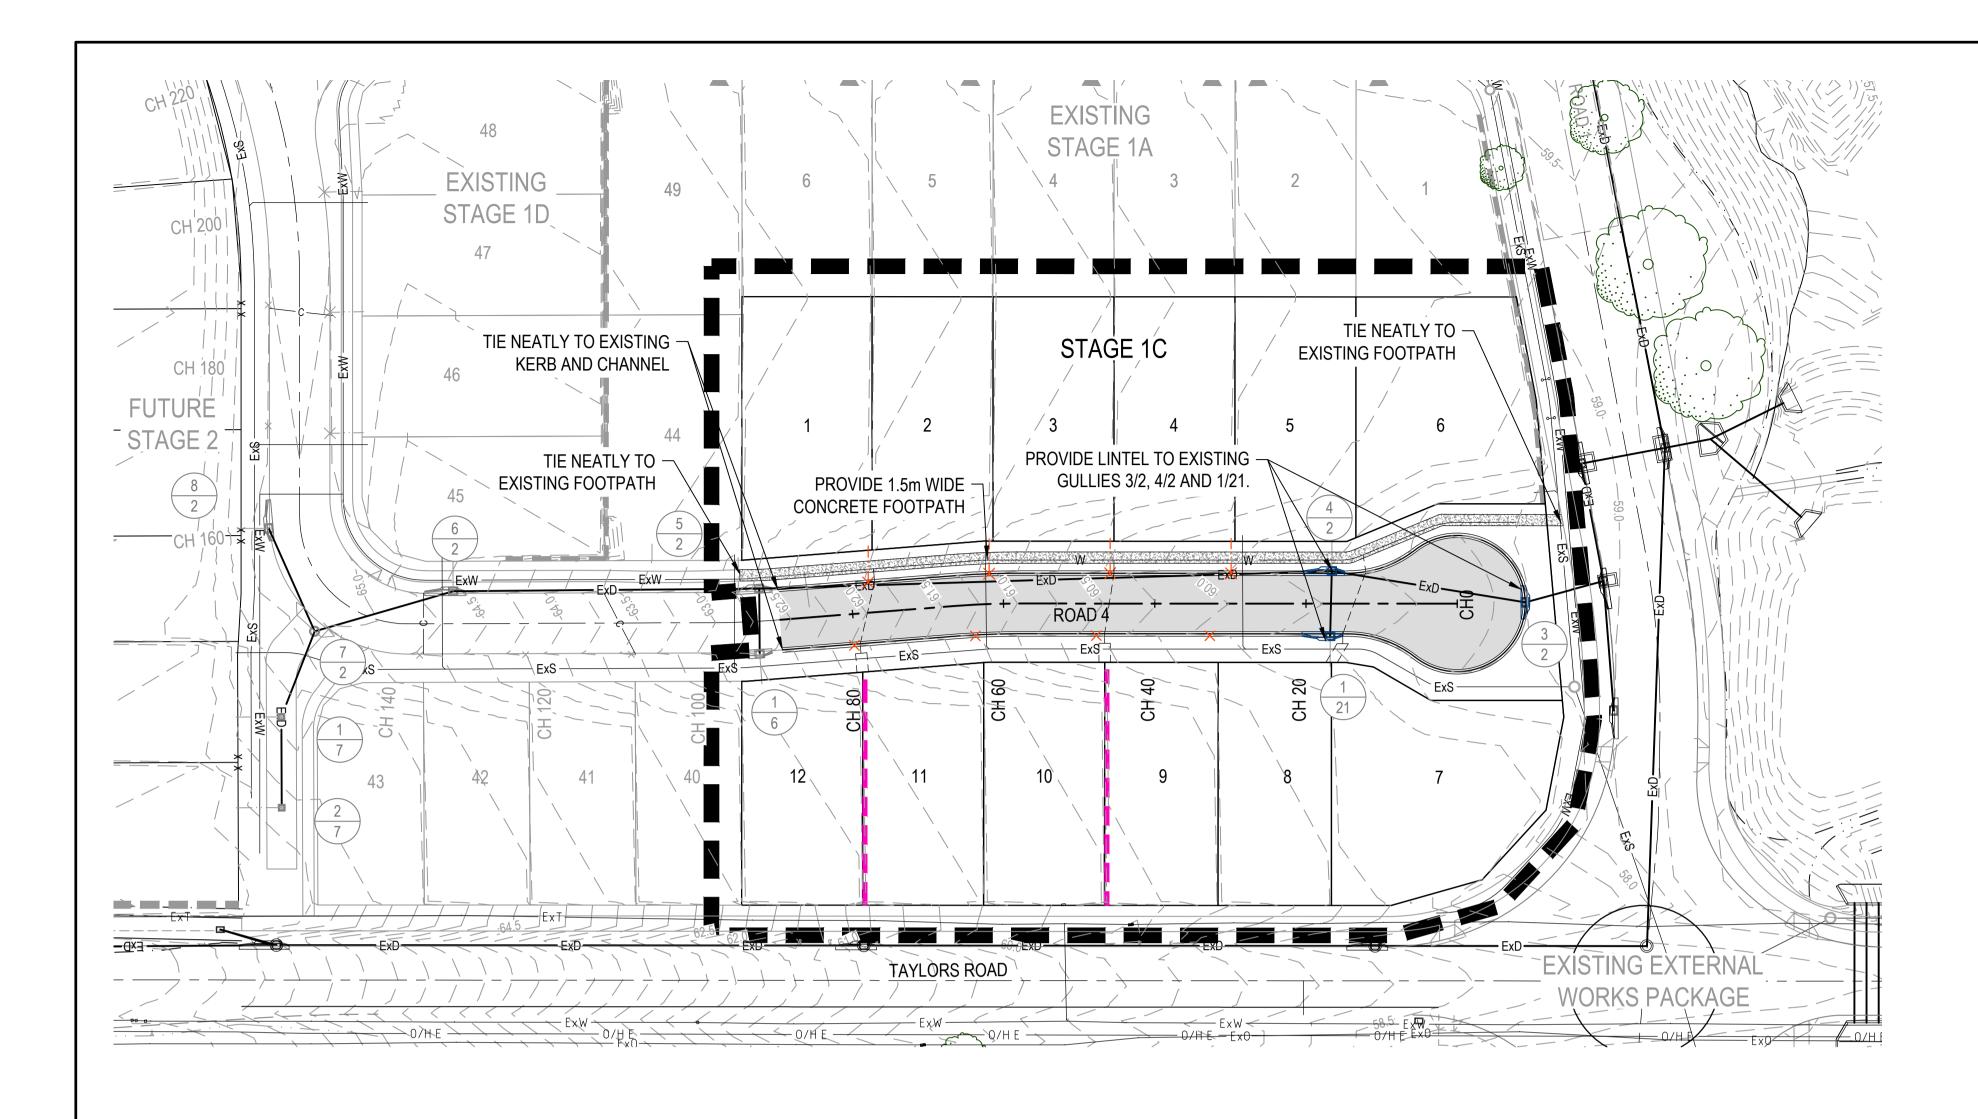

LEGEND

STAGE BOUNDARY FINISHED SURFACE CONTOUR (0.25m INTERVAL) PROPOSED RETAINING WALL **EXISTING RETAINING WALL** PROPOSED ROAD CONTROL LINE PROPOSED NEW PAVEMENT PROPOSED CONCRETE FOOTPATH AND KERB RAMP PROPOSED GULLY PIT LINTEL PROPOSED STORMWATER GULLY PIT WITH 150Ø ROOFWATER PIPE PROPOSED KERB ADAPTOR (2 KERB ADAPTORS TO BE CONSTRUCTED) PROPOSED KERB ADAPTOR WITH PIPE CONNECTION $\times \cdots -$ (2 KERB ADAPTORS TO BE CONSTRUCTED) **EXISTING STORMWATER DRAINAGE PIPE** PROPOSED WATER MAIN **EXISTING WATER MAIN EXISTING SEWER MAIN**

EXISTING TREE (TO REMAIN)

<u>NOTES</u>

- 1. REFER 30032006-01C-220 FOR ROAD LONGITUDINAL AND CROSS SECTIONS.
- 2. REFER 30032006-01C-330 FOR DRAINAGE LONGITUDINAL SECTIONS AND SETOUT DETAILS.

STORMWATER NOTES:

- 1. ALL STORMWATER CONSTRUCTION IS TO BE AS PER THE IPSWICH CITY COUNCIL DEVELOPMENT MANUAL & STANDARD DRAWINGS.
- 2. MANHOLES ARE TO HAVE FINISHED LID LEVELS 75mm ABOVE THE FINISHED SURFACE LEVEL ON ALL SIDES EXCEPT IN PAVED AREAS WHERE THEY ARE TO BE FINISHED FLUSH. FINISHED SURFACE LEVELS SHOWN ON THE DRAWINGS MAY BE INTERPOLATED & SHOULD BE CONFIRMED ON SITE PRIOR TO COMPLETING CONSTRUCTION.
- 3. HEADWALLS ARE TO BE APPROVED PRECAST UNITS U.N.O. SLOPING HEADWALLS ARE TO BE USED IN ACCORDANCE WITH COUNCIL REQUIREMENTS. CAST INSITU HEADWALLS ARE TO BE AS PER QUEENSLAND DEPARTMENT OF MAIN ROADS STANDARD DETAILS & SPECIFICATIONS.
- 4. SIDE ENTRY PITS ARE TO BE PRECAST SIDE INLET GULLY LIP IN LINE. REFER TO LONGSECTIONS FOR KERB & LINTEL SIZE.
- 5. SEEPAGE HOLES ARE TO BE PROVIDED IN THE WALL OF ALL PITS TO ACCEPT FLOWS FROM PIPE BEDDING.
- 6. AN APPROVED CONVERTER SLAB SHALL BE USED UNDER THE CHAMBER FOR SHAFT DIAMETERS LARGER THAN 1050mm.
- 7. THE GEOMETRIC CENTRE SHALL BE TAKEN AS THE SETOUT POINT FOR ALL STRUCTURES, UNLESS DETAILED OTHERWISE.
- 8. IN INSTANCES WHERE REAR ALLOTMENT DRAINAGE IS NOT PROVIDED, THE CONTRACTOR SHALL INSTALL A ROOFWATER CONNECTION TO EACH PROPERTY BY ONE OF THE FOLLOWING METHODS, AS SHOWN ON THE LAYOUT PLAN:
- TWO ROOFWATER KERB ADAPTOR 500mm FROM THE DOWNSTREAM BOUNDARY (UNLESS SHOWN ON A DIFFERENT ALIGNMENT). WHERE THERE IS A CONCRETE FOOTPATH, A ROOFWATER PIPE SHALL BE INSTALLED FROM THE PROPERTY BOUNDARY CONNECTED TO THE KERB ADAPTOR AT 1.25% MINIMUM GRADE IN ACCORDANCE WITH COUNCIL'S STANDARDS.
- ONE 150Ø ROOFWATER PIPE CONNECTED TO PROPOSED STORMWATER GULLY PIT OR MANHOLE AT MINIMUM 1.0% GRADE WITH 1.0m COVER.
- 9. ALL PVC PIPES ARE TO BE MINIMUM CLASS SN8.
- 10. END CAPS SHALL BE INSTALLED ON ENDS OF ALL PIPES AND STUBS.
- 11. PROPERTY CONNECTIONS SHALL BE 100Ø UNLESS SHOWN OTHERWISE. THE CONTRACTOR SHALL EXTEND CONNECTIONS A MINIMUM OF 1.0m BEYOND ADJACENT SEWER LINES, WHERE APPLICABLE.

Pursuant to the Planning Act 2016, this plan forms part of Council's approval for

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WARNING BEWARE OF UNDERGROUND SERVICES The locations of underground services are approximate only and their exact position should be proven on site. No guarantee is given that all existing services are shown.

No guarantee is given that all existing services are shown.

Locate all underground services before commencement of works


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						PAMELA ARCONADO	DATE 26.09.2022



(C) ABN 47 065 475 149



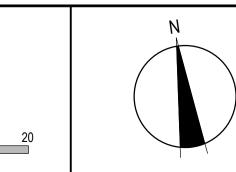

HIGHLAND - WALLOON
STAGE 1C
197 TAYLORS ROAD, WALLOON
IPSWICH CITY COUNCIL

ROADWORKS AND DRAINAGE LAYOUT PLAN

REVISION

SCALE | SIZE | PROJECT\DRAWING No | 30032066-01C-200

ASSUMED PAVEMENT DETAILS


ROAD	ROAD CLASSIFICATION	ASSUMED CBR	DESIGN ESAs	SURFACING	BASE	UPPER SUB BASE	LOWER SUB BASE	*SUBGRADE REPLACEMENT	TOTAL DEPTH
ROAD 4	ACCESS STREET	3	1.0 x 10 ⁵	35mm AC10	125mm	100mm	165mm	-	425mm

*PRELIMINARY ONLY. TBC - SUBJECT TO CBR TESTING.

NOTES:

- 1. MINIMUM PAVEMENT DESIGN IS PRELIMINARY ONLY AND BASED ON ASSUMED SUBGRADE CBR. ACTUAL PAVEMENT WILL BE BASED ON ACTUAL SUBGRADE TEST RESULTS.
- 2. THE CONTRACTOR IS RESPONSIBLE TO SUPPLY THE SUPERINTENDENT WITH THE NECESSARY SUBGRADE TEST RESULTS, REQUIRED FOR THE FINAL PAVEMENT DESIGN.
- 3. WHERE THE TOTAL PAVEMENT DEPTH (AS DETERMINED BY SUBGRADE TESTS) EXCEEDS THE NOMINAL DEPTH AS ASSUMED, THE PAVEMENT GRAVEL SHALL EXTEND UNDER THE KERB AND CHANNEL TO 150MM BEHIND (TYP).
- 4. BOXING DEPTH SHOWN ON CROSS-SECTIONS IS INDICATIVE ONLY.
- # REFER TO CULDESAC DETAILS FOR LEVELS.

Pursuant to the Planning Act 2016, this plan forms part of Council's approval for

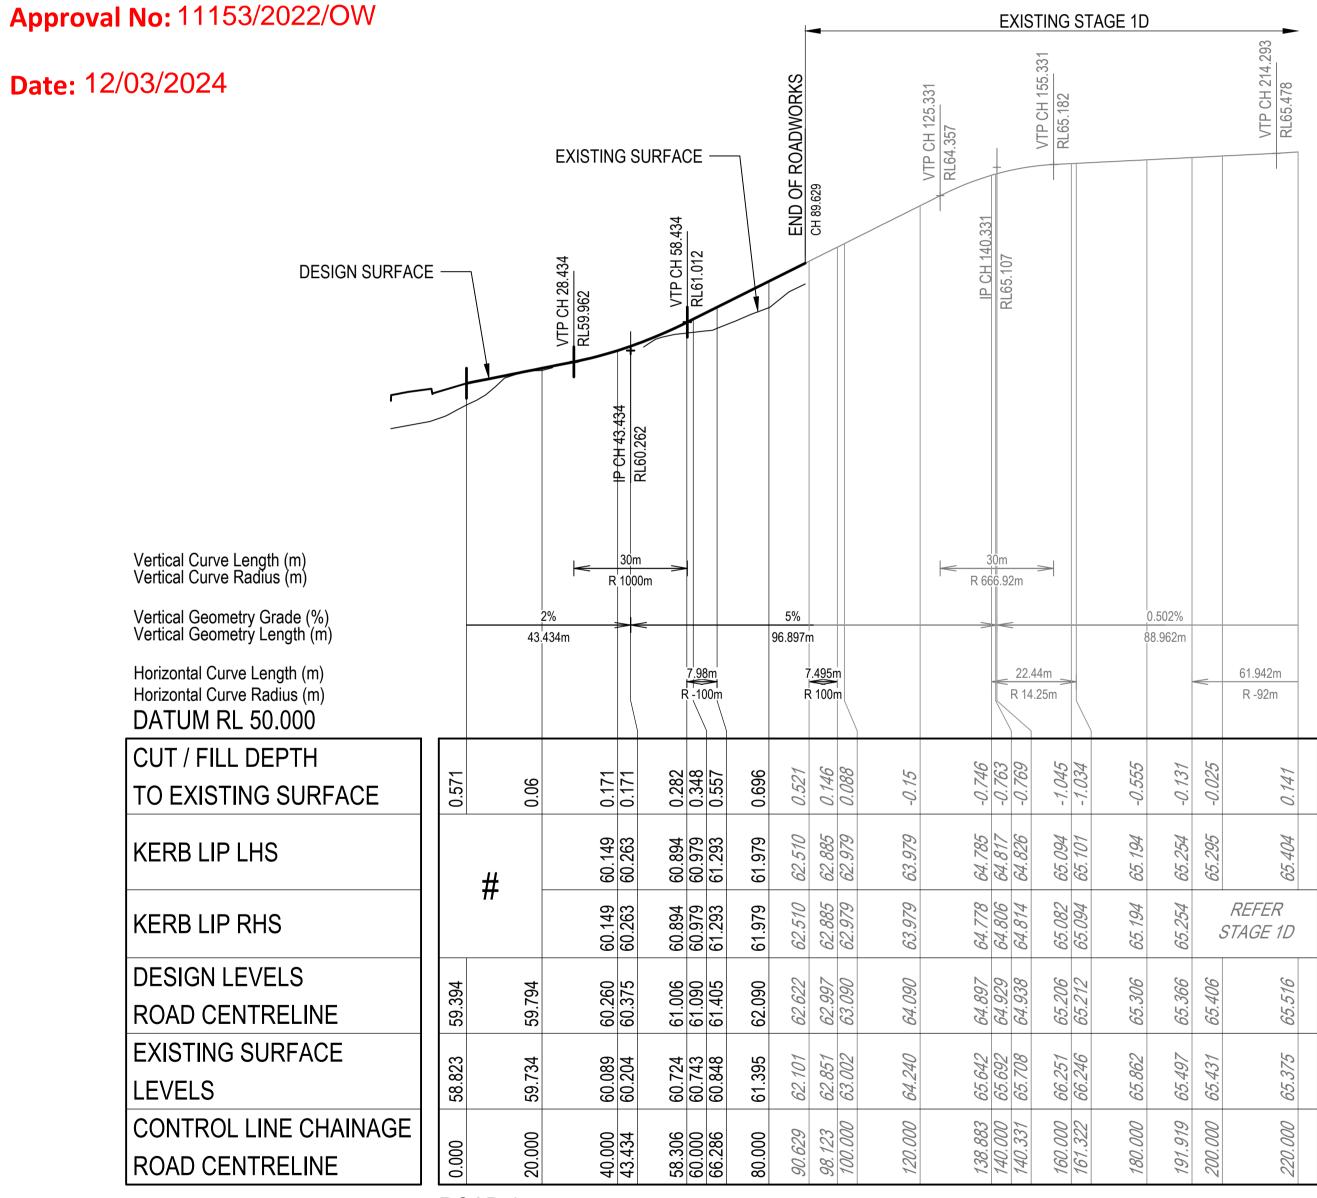

ROAD 4
SCALE: HORIZONTAL - 1:1000
VERTICAL - 1:100

REV DATE AMENDMENT \ REVISION DESCRIPTION

01 26.09.22 ISSUED FOR APPROVAL

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SUBJECT TO APPROVAL

APPROVED


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PAMELA ARCONADO

DATE 26.09.2022



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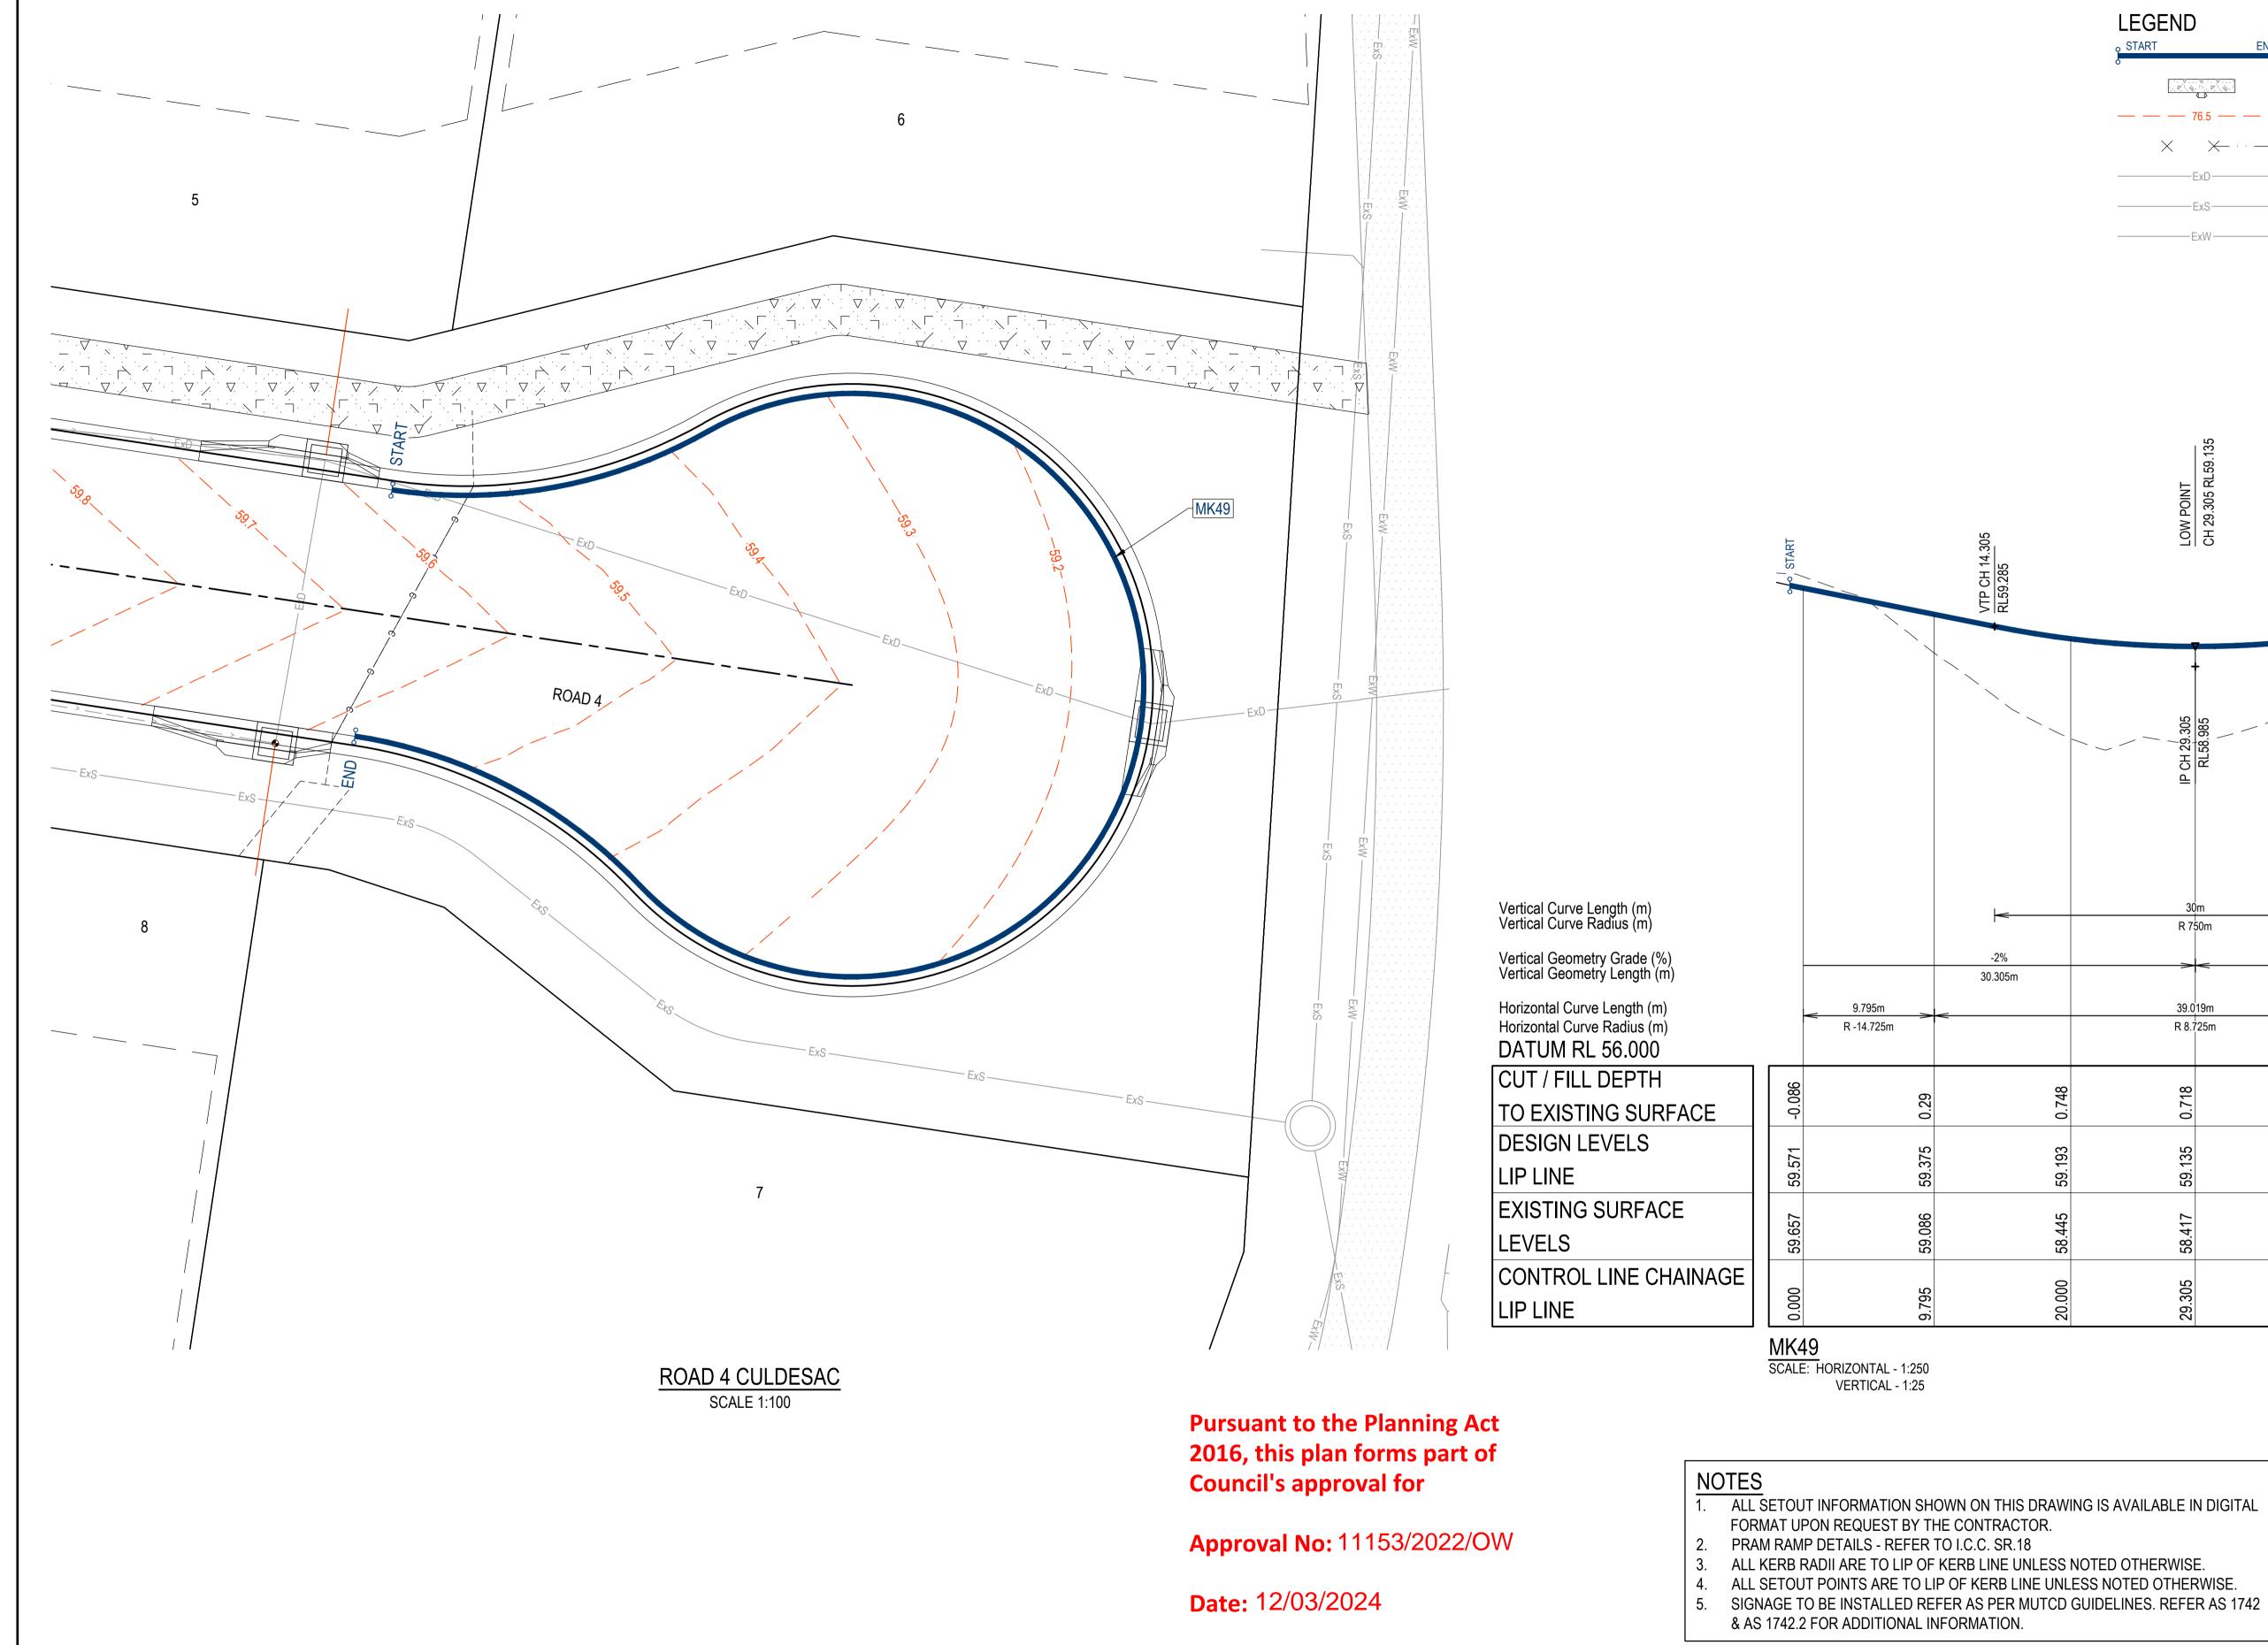


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 RL 60.0 CH 80.000	1 in 7.68 29	0	-3%	-3%	0	2%	EW PAD
PL 58.0 CH 60.000	1 in 9.94 29	•	-3% 	-3%	0	2%	EW PAD
RL 58.0 CH 40.000	8.01% 2%		-3%		0	Z%	EW PAD
OB MB — — — — — — — — — — — — — — — — — — —	3.7 A.6% 2%	5m	16.0m ROA 8.0m CARR	ND RESERVE RIAGEWAY	1.5m	4.25m 1.5m 2% 1.5m WIDE FOOTP	EW PAD
CH 20.000	MOUNTABLE KERB ANI CHANNEL TYPE M REFER I.C.C. STD DRG SR.1	1	CUL-DE		-1.53%	SUBSURFACE DRAINAGE REFER I.C.C. STD. DRG S	

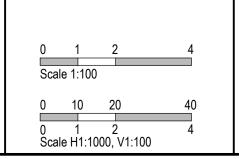

- ALL SETOUT INFORMATION SHOWN ON THIS DRAWING IS AVAILABLE IN DIGITAL

WARNING BEWARE OF UNDERGROUND SERVICES

PROPOSED KERB SETOUT

EXISTING STORMWATER

EXISTING SEWER MAIN

EXISTING WATER MAIN

30.305m

9.795m

R -14.725m

PROPOSED CONCRETE FOOTPATH AND KERB RAMP

PROPOSED KERB ADAPTOR (WITH PIPE CONNECTION)

EXISTING SURFACE CONTOURS (0.1m INTERVAL)

The locations of underground services are approximate only and their exact position should be proven on site.

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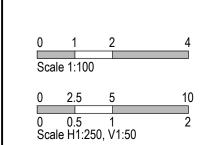
Locate all underground services before commencement of works **DIAL 1100 BEFORE YOU DIG**


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						APPROVED	RPEQ: 10082	
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						PAMELA ARCONADO	DATE 26.09.2022	



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CLIENT	PROJECT
LENNIUM	
G R O U P	DATUM

HIGHLAND - WALLOON STAGE 1C 197 TAYLORS ROAD, WALLOON IPSWICH CITY COUNCIL


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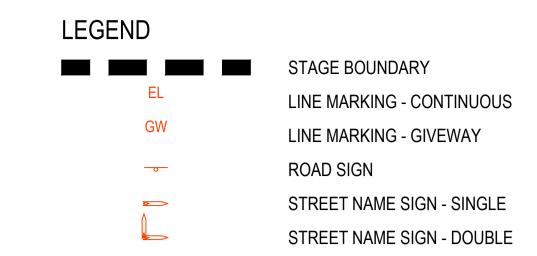
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ROADWORKS **CULDESAC DETAILS** LAYOUT PLAN

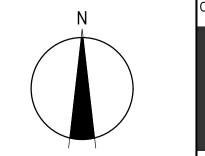PROJECT\DRAWING No 30032066-01C-260

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NOTES:

- ALL SIGNS AND LINEMARKING TO BE IN ACCORDANCE WITH THE
- 2. LINE-MARKING AND SIGNAGE IS TO BE CONSTRUCTED IN ACCORDANCE WITH AS1742.2-2009 - PAVEMENT MARKINGS AND AS1742.10-2009 - PEDESTRIAN CONTROL AND PROTECTION.
- 3. EXTENT OF LINE-MARKING IS TO BE VERIFIED ON SITE WITH THE SUPERINTENDENT PRIOR TO INSTALLATION.
- 4. EXACT LOCATION OF ALL SIGNS IS TO BE VERIFIED ON SITE WITH THE SUPERINTENDENT PRIOR TO INSTALLATION.
- 5. INSTALL TACTILE GROUND SURFACE INDICATORS (TGSI'S) TO AS1428 TO ALL NEW KERB RAMPS.
- 6. REFER TO IPWEAQ STANDARD DRAWING SEQ R-130 FOR STREET SIGN DETAILS.
- REFER TO IPWEAQ STANDARD DRAWING SEQ R-131 FOR TRAFFIC SIGN DETAILS.

WARNING BEWARE OF UNDERGROUND SERVICES
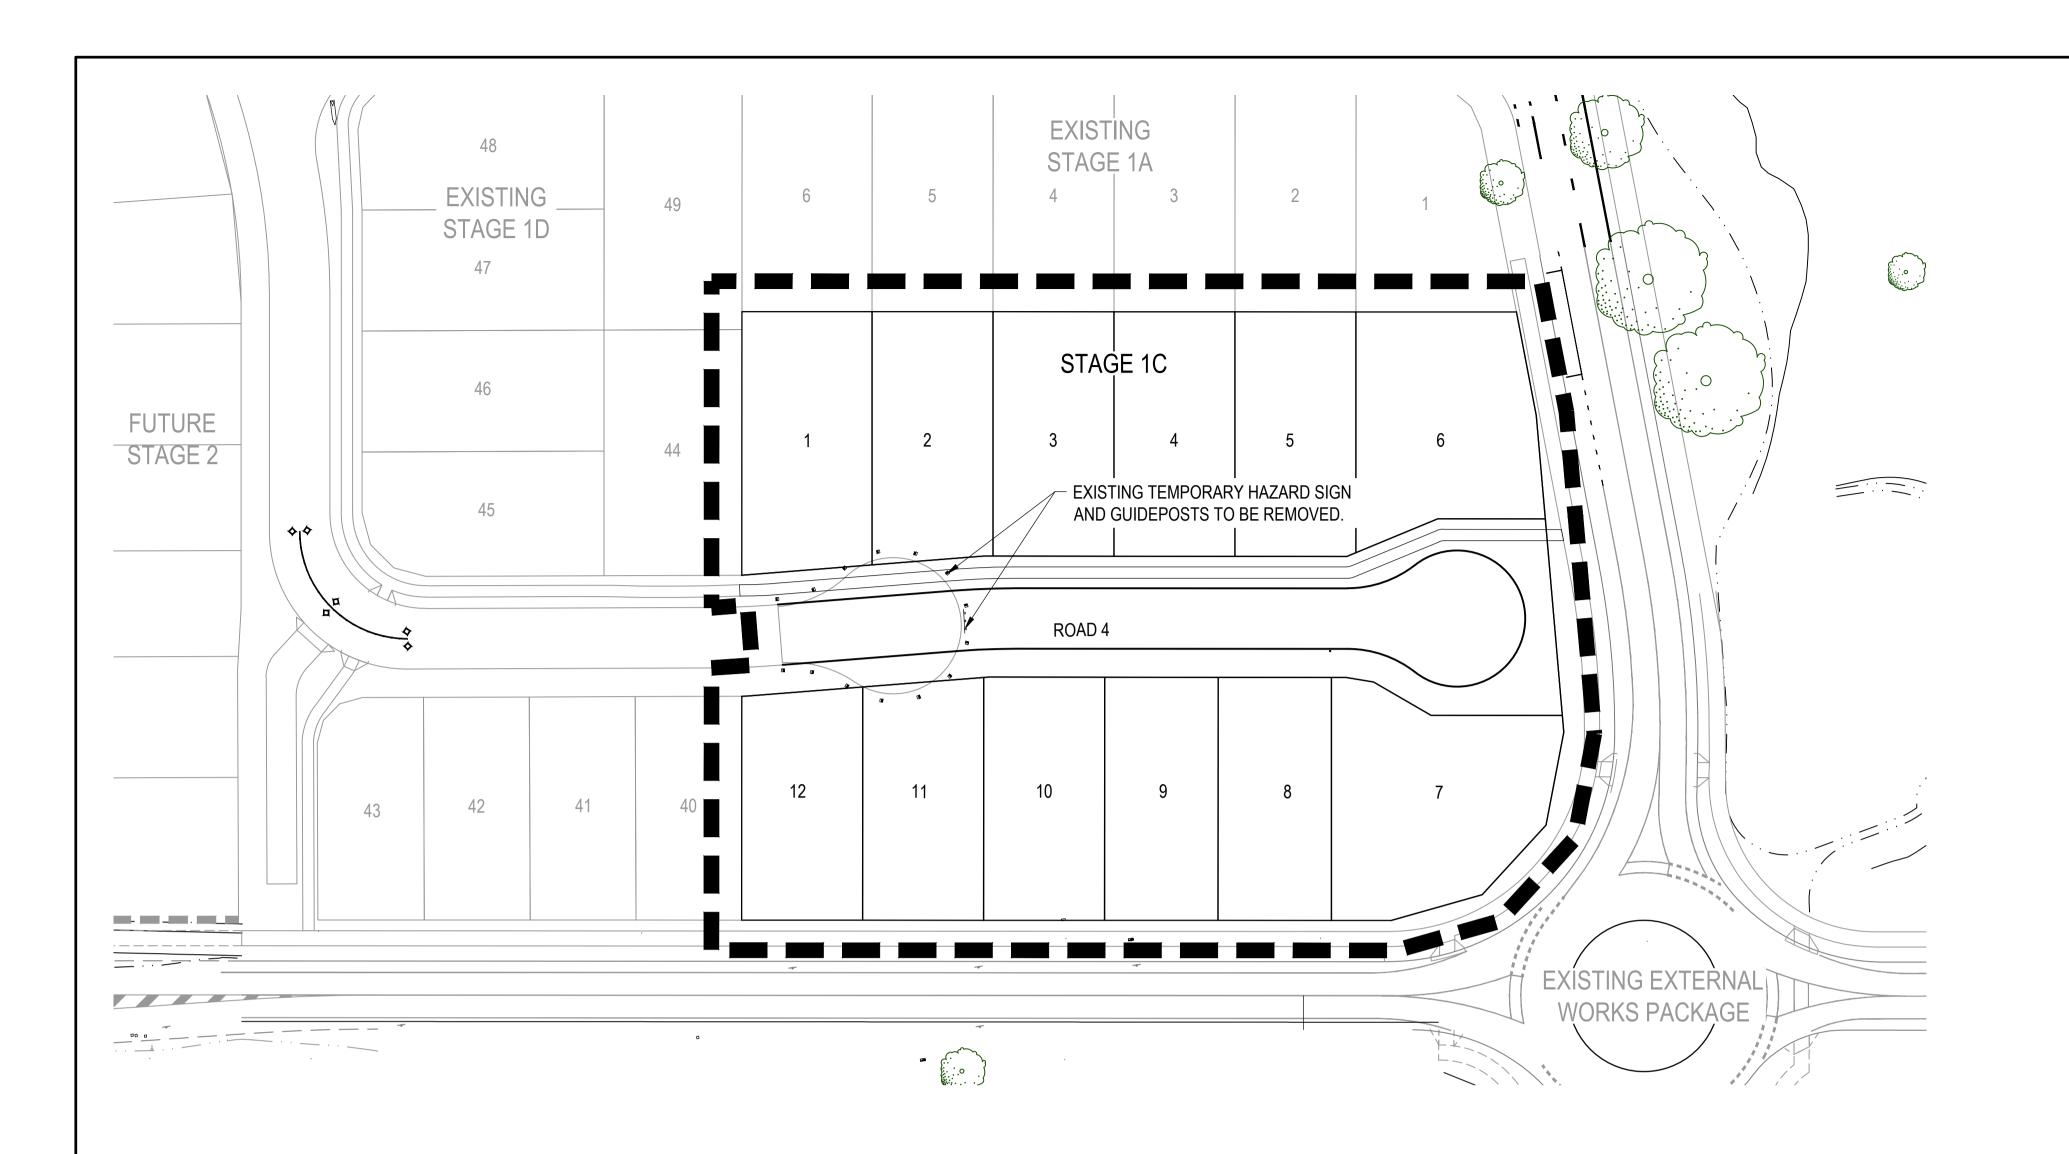
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<u>DIAL 1100 BEFORE YOU DIG</u> www.1100.com.au

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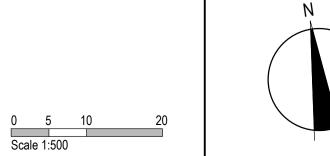
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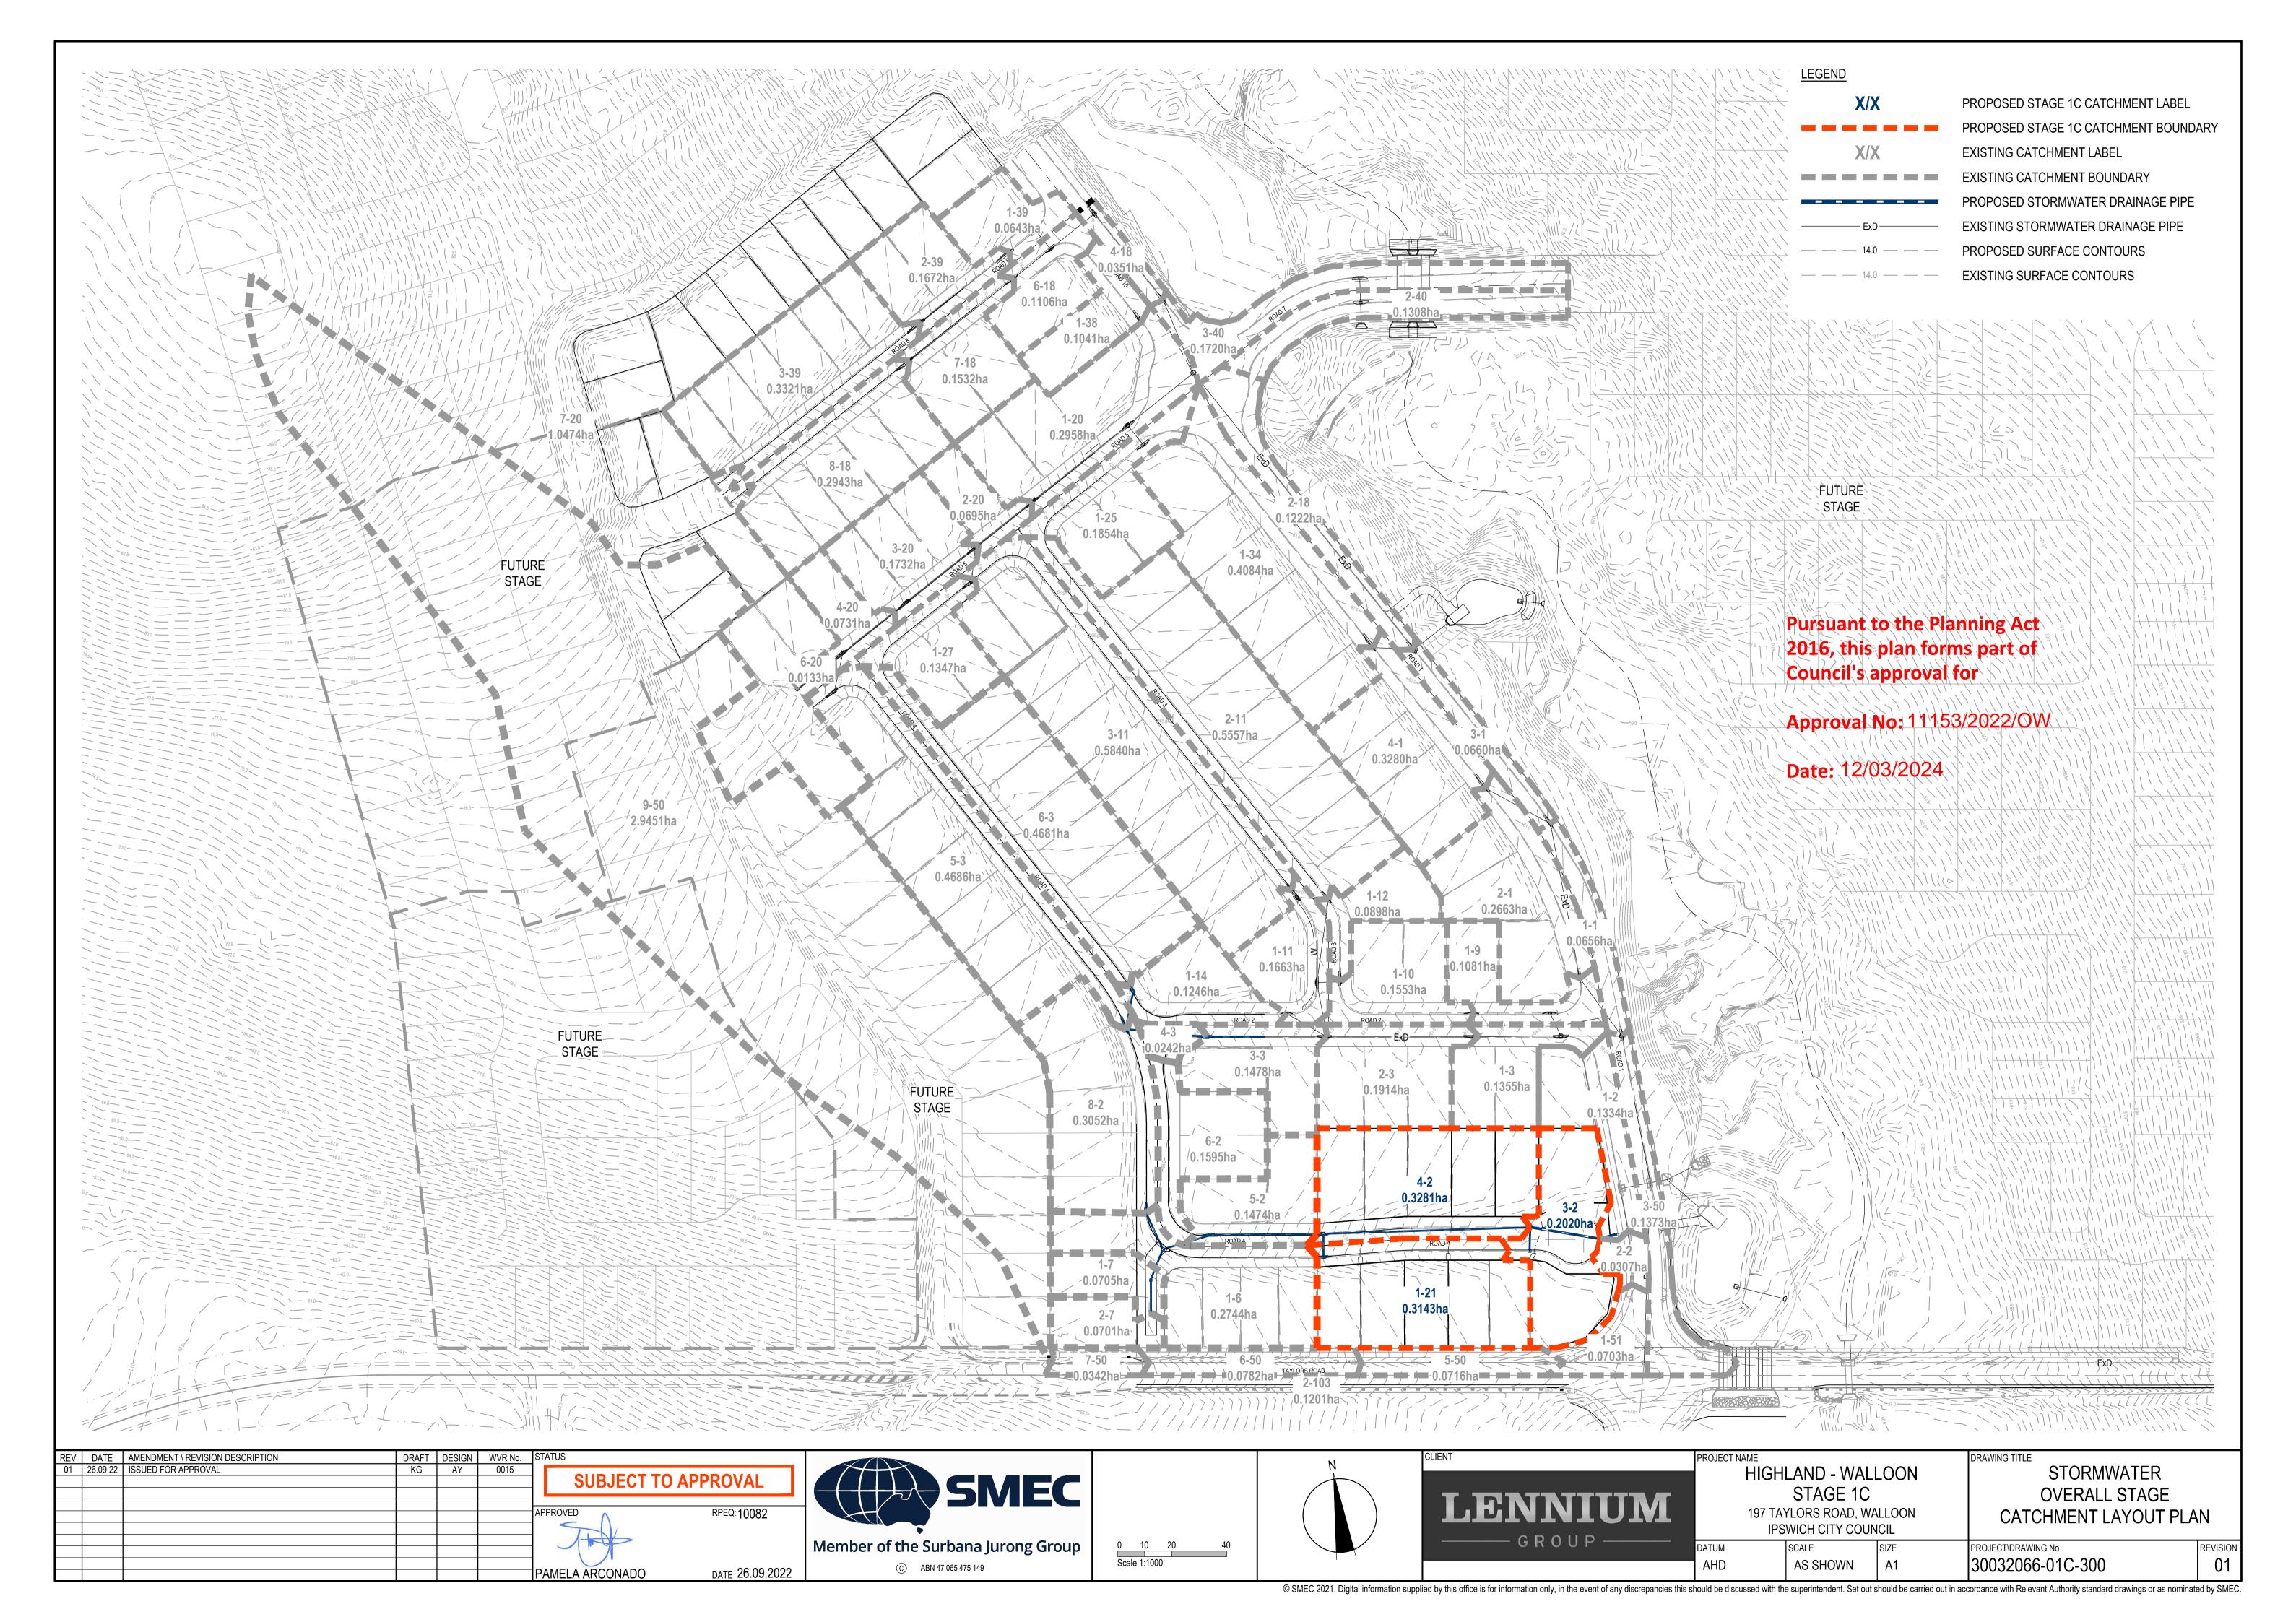



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HIGHLAND - WALLOON	
STAGE 1C	
197 TAYLORS ROAD, WALLOON	
IPSWICH CITY COUNCIL	

ROADWORKS SIGNAGE & LINEMARKING LAYOUT PLAN

PROJECT\DRAWING No 30032066-01C-280


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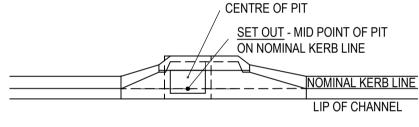


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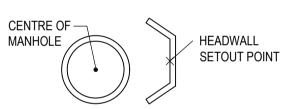
- 1. REFER PROJECT DRAWING 200 FOR STORMWATER DRAINAGE LAYOUT PLAN.
- 2. REFER PROJECT DRAWING 300 FOR STORMWATER OVERALL STAGE CATCHMENT PLAN.
- 3. 2 YEAR MINOR STORM EVENT FOR ACCESS STREETS AND 10 YEAR MINOR STORM EVENT FOR COLLECTOR STREETS & 100 YEAR MAJOR STORM EVENT HAVE BEEN ADOPTED.
- 4. STRUCTURE LOCATION CO-ORDINATES FOR ALL "SIDE ENTRY" PITS HAVE BEEN TAKEN ON THE NOMINAL KERB LINE AT THE PITS MID POINT. REFER DETAIL BELOW.
- 5. STRUCTURE LOCATION CO-ORDINATES FOR ALL "SIDE ENTRY PITS ON CIRCULAR MANHOLES HAVE BEEN TAKEN ON THE NOMINAL KERB LINE AT THE INLET PITS MID POINT. MANHOLES TO BE OFFSET TOWARD PAVEMENT. REFER DETAILS BELOW.
- 6. STRUCTURE LOCATION CO-ORDINATES FOR ALL MANHOLES HAVE BEEN TAKEN ON THE CENTRE OF EACH PIT. REFER DETAIL BELOW.
- 7. STRUCTURE LOCATION CO-ORDINATES FOR ALL HEADWALLS HAVE BEEN TAKEN AT THE DOWNSTREAM INVERT OF THE PIPE. REFER DETAIL BELOW.

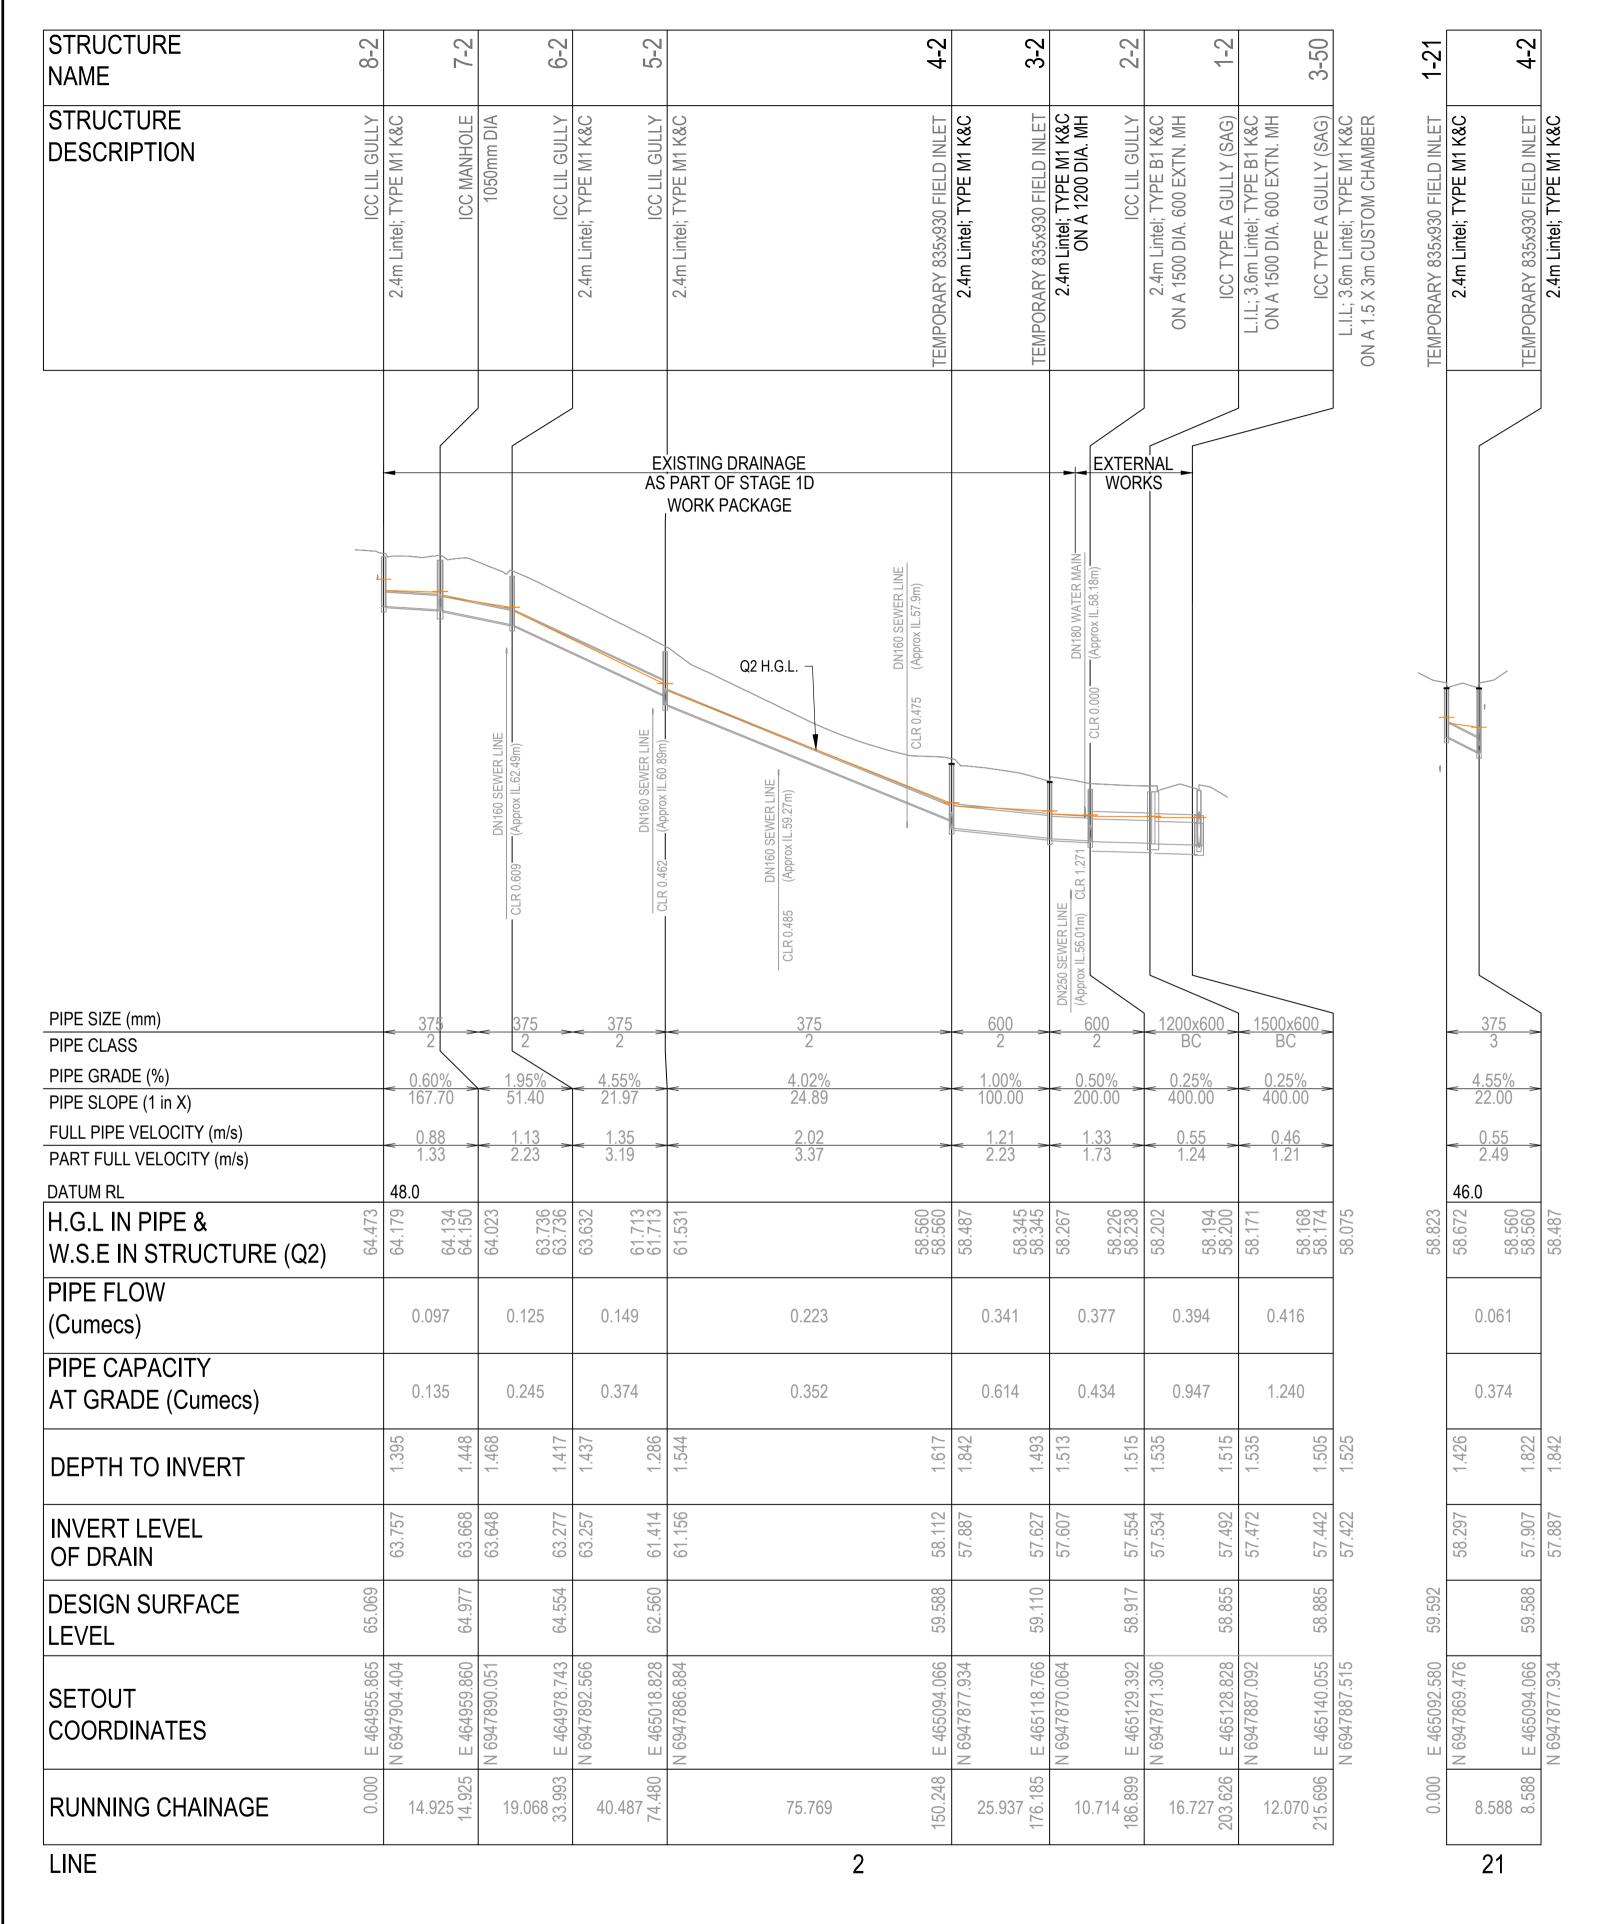

SIDE ENTRY PIT ON CIRCULAR MANHOLE SETOUT POINT

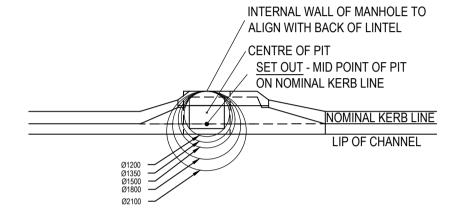

SIDE ENTRY PIT SETOUT POINT



Pursuant to the Planning Act 2016, this plan forms part of Council's approval for


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						APPROVED	RPEQ: 10082
						DAMELA ADCONADO	26 00 2022
						PAMELA ARCONADO	DATE 26.09.2022



(C) ABN 47 065 475 149



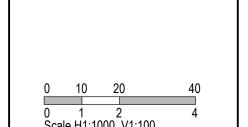

HIGHLAND - WALLOON
STAGE 1C
197 TAYLORS ROAD, WALLOON
IPSWICH CITY COUNCIL

AS SHOWN

A1

STORMWATER LONGITUDINAL SECTIONS

01

PROJECT\DRAWING No 30032066-01C-330